STANDARD ABBREVIATIONS

AIR CONDITIONING **ACCESSORY**

ABOVE FINISH FLOOR

AMERICANS with DISABILITIES ACT

ASSESSOR'S PARCEL NUMBER

ENERGY EXPENDITURE PLAN

NUMBER

PERCENT

ALTERNATE

BOARD

BUILDING

BLOCKING

CENTERLINE

CONTINUOUS

DEMOLITION

DEPARTMEN

CEILING

COUNTER

DOUBLE

DETAIL

DIAMETER

DIMENSION

DRAWING FAST

EXISTING

ELECTRICAL

EQUIPMENT

EACH WAY

EXTERIOR

FIRE ALARM

FLOOR DRAIN

FINISH FLOOR

FACE OF FINISH

FIBERGLASS REINFORCED

GALVANIZED SHEET METAL

GENERAL CONTRACTOR

GROUND FAULT CIRCUIT

FACE OF STUD

FOOT or FEET

INTERRUPTER

GYPSUM BOARD

FIRE EXTINGUISHER

EACH

EQUAL

FINISH

FLOOR

PLASTIC

GENERAL

GRADE

HOSE BIB

HARDWOOD

HARDWARE

HORIZONTAL

INSULATION

MECHANICAL

PLUMBING

NOMINAL

NOT TO SCALE

OUTSIDE DIAMETER

ON CENTER

OPPOSITE

PROPOSED

PLYWOOD

RADIUS

RUBBER BASE

ROOF DRAIN

REFERENCE

REINFORCE

RESILIENT

SOUTH

SOLID CORE

SCHEDULE

SECTION

ROUGH OPENING

REMOVE & RELOCATE

SEAT COVER DISPENSER

SEE ELECTRICAL DRAWINGS

PROPERTY LINE

PLASTIC LAMINATE

PATH OF TRAVEL

MAXIMUM

HOLLOW METAL

INSIDE DIAMETER

LONG or LENGTH

MANUFACTURE or MANUFACTURER

MISCELLANEOUS

MOISTURE RESISTANT

NOT IN CONTRACT (NO WORK)

ORIENTED STRAND BOARD

PAPER TOWEL DISPENSER

REQUIRED or REQUIREMENT

POLYVINYL CHLORIDE PUBLIC UTILITY EASEMENT

FOR EXAMPLE, SUCH AS

INTERIOR or INTEGRAL

CLEAR

BACK OF CURB

A.F.F

BLDG.

BLKG.

B.O.C.

C.B.C.

CL or ⊈

CLR.

CTR.

DBL.

DEPT.

DET.

DIM.

DWG.

EEP

ELEC.

EQUIP.

EQ.

EXT.

F.O.S.

GEN.

GFCI

HDWD

HDW.

H.M. HORIZ

N.T.S.

O.D.

OPP.

O.S.B.

PL or 12

PLYWD.

PLAM.

P.O.T.

P.T.D.

P.U.E.

REF

RES.

R.O.

S.C.

S.C.D.

SCHED.

SECT.

S.E.D.

S.F.

SHT.

SIM.

S.M.D.

SPEC.

SQ.FT.

STRUCT

STL. STOR.

SYM

T.B.D.

TEMP.

THK.

TMP.

T.O.

U.C.

U.O.N.

VERT.

VEST.

V.I.F.

WD.

W.R.

WT.

WIND.

WSCT.

REINF.

DIA. or

CONT

GENERAL NOTES

- DO NOT SCALE THE DRAWINGS. EVERY ATTEMPT HAS BEEN MADE TO SHOW ITEMS TO SCALE, BUT NO GUARANTEE IS IMPLIED. ALWAYS INFORM THE ARCHITECT OF MISSING, INCOMPLETE, OR IMPROPER DIMENSIONS ON THE PLANS, OR WHEN EXISTING CONDITIONS DO NOT MATCH WHAT IS SHOWN ON THE PLANS. VERIFY CRITICAL DIMENSIONS.
- DIMENSIONS TO EXISTING CONSTRUCTION ARE GIVEN TO FACE OF FINISH, UNLESS INDICATED OTHERWISE.
- SPECIFICATIONS ARE NOTED THROUGHOUT THE PLANS. CONTACT ARCHITECT FOR CLARIFICATIONS
- IF PROVIDED, SEE ELECTRICAL, CIVIL AND PLUMING DRAWINGS FOR RELATED WORK AND EQUIPMENT. WHERE ELECTRICAL ITEMS ARE SHOWN, AND NO DIMENSIONS OR OTHER FORMS OF LOCATION INFORMATION ARE PROVIDED, THE ARCHITECTURAL DRAWINGS SHALL GOVERN WITH RESPECT TO LOCATION
- IF INDICATED, PROVIDE ALTERNATE BIDS AS DESCRIBED IN THE PLANS AND IN BID INSTRUCTIONS
- SINCE THE WORK INCLUDES ALTERATIONS OF EXISTING FACILITIES. EXAMINATION OF THE EXISTING CONSTRUCTION SHALL BE MADE BY THE GENERAL CONTRACTOR AS IT RELATES TO THE WORK. THE GENERAL CONTRACTOR SHALL VERIFY EXISTING CONDITIONS AND DIMENSIONS AS REQUIRED. NO ALLOWANCE SHALL BE ALLOWED FOR ANY EXPENSE INCURRED DUE TO FAILURE OR NEGLECT TO EXAMINE AND VERIFY EXISTING CONDITIONS. ANY CONFLICTS, OMISSIONS,
- THE PURPOSE OF THESE DOCUMENTS IS TO SHOW THE GENERAL ARRANGEMENT AND EXTENT OF NEW WORK INCLUDING ADDITIONS, ALTERATIONS AND INTERFACING. ASSUMPTIONS HAVE BEEN MADE REGARDING ARCHITECTURAL, STRUCTURAL AND SYSTEM FEATURES OF EXPOSED AND CONCEALED EXISTING CONSTRUCTION PRODUCT WITHIN THE SCOPE OF THIS CONTRACT, BUT WHICH IS NOT SPECIFICALLY INCLUDED IN THESE DOCUMENTS
- THERE WILL BE NO SUBSTITUTION FOR SPECIFIED ITEMS WITHOUT PRIOR WRITTEN APPROVAL, UNLESS OTHERWISE NOTED IN THESE PLANS. REQUESTS FOR SUBSTITUTIONS SHALL BE MADE IN WRITING TO THE ARCHITECT AND
- REMOVE PORTIONS OF EXISTING CONSTRUCTION AS NECESSARY TO ACCOMMODATE NEW CONSTRUCTION AND REPLACE, PATCH OR REPAIR AS NEEDED. PROTECT AREA FROM DAMAGE WHICH MAY OCCUR FROM DEMOLITION. DUST, WATER, ETC. PROVIDE AND MAINTAIN TEMPORARY BARRICADES, CLOSURE WALLS, ETC. AS REQUIRED DURING
- DAMAGE TO EXISTING STRUCTURES. FINISH, AND EQUIPMENT SHALL BE REPAIRED OR REPLACED TO THE SATISFACTION
- THE FINAL LOCATION OF ALL ELECTRICAL AND SIGNAL EQUIPMENT, PANEL BOARDS, FIXTURES, OUTLETS, ETC. SHALL BE APPROVED BY OWNER PRIOR TO INSTALLATION.
- DIMENSIONS NOTED "CLEAR" OR "CLR." MUST BE PRECISELY MAINTAINED. DO NOT SCALE DRAWINGS. ANY DISCREPANCIES SHALL BE BROUGHT TO THE ATTENTION OF THE ARCHITECT FOR CLARIFICATION PRIOR TO DEMOLITION, FABRICATION OR CONSTRUCTION, DIMENSIONS ARE NOT ADJUSTABLE WITHOUT WRITTEN APPROVAL
- DIMENSIONS NOTED "V.I.F." OR "VERIFY" SHALL BE VERIFIED IN THE FIELD BY THE CONTRACTOR PRIOR TO THE START OF FABRICATION OR CONSTRUCTION. VERIFY ALL ROUGH OPENING DIMENSIONS, FOR FABRICATED ITEMS, WITH THE MANUFACTURER PRIOR TO CONSTRUCTION.
- EACH FLOOR LEVEL IS ESTABLISHED AT +0.00' AND SHALL BE USED AS A REFERENCE FOR THAT LEVEL'S ELEVATIONS.
- PROVIDE REQUIRED BLOCKING AND BRACING FOR ALL WALL MOUNTED FIXTURES, ACCESSORIES AND EQUIPMENT.
- THE CONTRACTOR SHALL BE RESPONSIBLE FOR REMOVING ALL LEFTOVER MATERIALS, DEBRIS, TOOLS AND EQUIPMENT INVOLVED IN HIS OPERATIONS AT THE CONCLUSION OF THE WORK. LEAVE ALL AREAS CLEAN AND IN
- CONTRACTOR SHALL REPAIR OR REPLACE ANY FENCE, SIDEWALK, PAVING, LANDSCAPING, ELEVATOR, FLOORING OR ANY OTHER BUILDING MATERIAL OR SYSTEM DAMAGED AS A RESULT OF LABOR, MATERIAL AND EQUIPMENT DELIVERY
- PRESENCE, HANDLING, REMOVAL OR DISPOSAL OF, OR EXPOSURE OF PERSONS TO ASBESTOS, HAZARDOUS OR TOXIC SUBSTANCES IN ANY FORM AT THE PROJECT SITE. PROFESSIONAL SERVICES RELATED OR IN ANY WAY CONNECTED WITH THE INVESTIGATION, DETECTION, ABATEMENT, REPLACEMENT, USE, SPECIFICATION, OR REMOVAL OF PRODUCTS MATERIALS OR PROCESSES CONTAINING ASBESTOS, HAZARDOUS OR TOXIC MATERIALS ARE BEYOND THE SCOPE OF
- SHALL BE IN ACCORDANCE WITH TITLE 24, CALIFORNIA CODE OF REGULATIONS. SHOULD ANY EXISTING CONDITIONS SUCH AS DETERIORATION OR NONCOMPLIANT CONSTRUCTION, BE DISCOVERED WHICH IS NOT COVERED BY THE CONTRACT DOCUMENTS, WHEREIN THE FINISHED WORK SHALL NOT COMPLY WITH TITLE 24, CALIFORNIA CODE OF REGULATIONS, CONTRACTOR SHALL NOTIFY ARCHITECT IMMEDIATELY AND WAIT FOR INSTRUCTION BEFORE

NEVADA JOINT UNION HIGH SCHOOL DISTRICT

NEVADA UNION HIGH SCHOOL 'J' WING STAIR REPLACEMENT

11761 RIDGE ROAD GRASS VALLEY, CA 95945

PROJECT TEAM PROJECT REQUIREMENTS SHEET INDEX CONTACT: JORDAN KOHLER 2019 CALIFORNIA GREEN CODE - TITLE 24, Part 11 DIRECTOR OF FACILITIES AND CONSTRUCTION 2019 CALIFORNIA ADMINISTRATIVE CODE - TITLE 24. Part 1 NEVADA JOINT UNION HIGH SCHOOL DISTRICT 2019 CALIFORNIA BUILDING CODE - TITLE 24, Part 2 A1.1 SITE PLAN 11645 RIDGE RD. 2019 CALIFORNIA ELECTRICAL CODE - TITLE 24, Part 3 A1.2 FLOOR PLAN, SECTIONS AND DETAILS GRASS VALLEY, CA 95945 2019 CALIFORNIA MECHANICAL CODE - TITLE 24, Part 4 530.273.3351 ext 221 2019 CALIFORNIA PLUMBING CODE - TITLE 24, Part 5 jkohler@njuhsd.com STRUCTURAL 2019 CALIFORNIA ENERGY CODE - Part 6 2019 CALIFORNIA FIRE CODE - Part 9 S2.1 STAIR FDN PLAN, 2ND FLR FRMG PLAN & GENERAL NOTS CONTACT: CRAIG SCOTT 2019 CALIFORNIA EXISTING BUILDING CODE - TITLE 24. Part 10 S3.1 DETAILS DERIVI CASTELLANOS ARCHITECTS, INC. 2019 CALIFORNIA REFERENCED STANDARDS CODE, TITLE 24, Part 12 3031 WEST MARCH LANE, SUITE 334 TITLE 19 CCR, PUBLIC SAFETY, STATE FIRE MARSHAL REGULATIONS STOCKTON, CA 95219 PHONE: 209.761.1265 2019 NFPA 72 NATIONAL FIRE ALARM AND SIGNALING CODE (CA AMENDED) E-MAIL: cscott@dcaaia.com RULES AND REGULATIONS OF THE LOCAL UTILITY COMPANY DONALD C. URFER & ASSOCIATES A COPY OF PARTS I & II OF TITLE 24 SHALL BE KEPT AND AVAILABLE IN THE FIELD DURING 2715 PORTER STREET SOQUEL, CA 95073 PHONE: 831.476.3681 E-MAIL: scott@dcurfer.com LOCAL FIRE JURISDICTION: NEVADA COUNTY CONSOLIDATED FIRE DISTRICT PROJECT DESCRIPTION REPLACEMENT IN-KIND OF AN EXISTINGEXTERIOR STAIRWAY AT "J" BUILDING, DUE TO EXCESSIVE COROSSION AND CONSIDERED UNSAFE BY THE DISTRICT. REPLACEMENT STAIRWAY TO MATCH EXISTING ON SITE BUT COMPLY WITH CURRENT ACCESSIBILITY REQUIREMENTS PER CBC 2019. PER DSA IR A-10 THIS PROJECT IS EXEMPT FROM DSA REVIEW THE DISTRICT WILL RETAIN AN IOR TO OBSERVE THE REPLACEMENT WORK

A0.1 COVER SHEET, SHEET INDEX, PROJECT DATA, NOTES, ABBREVIATIONS

VICINITY MAP DSA INFORMATION



NOT TO SCALE - PROJECT SITE

FLOOD HAZARD MAP

NOT TO SCALE

- AS A FACILITY WHICH COMES UNDER THE APPROVAL OF THE DIVISION OF THE STATE ARCHITECT (DSA), THIS PROJECT IS SUBJECT TO DRAWING AND SITE REVIEW BY A
- CHANGES TO THE APPROVED DRAWINGS AND SPECIFICATIONS SHALL BE MADE BY ADDENDA OR CONSTRUCTION CHANGE DOCUMENT, APPROVED BY THE DIVISION OF THE
- THE ARCHITECT SHALL NOTIFY DSA OF THE START-UP OF CONSTRUCTION.
- PROVIDE CONTINUOUS INSPECTION OF THE WORK.
- ADMINISTRATION OF CONSTRUCTION PER PART 1, TITLE 24 CCR
 - VERIFIED REPORTS PER SECTION 4-336
- COMPLIANCE WITH CFC CHAPTER 33 FIRE SAFETY DURING CONSTRUCTION AND
- SHOULD ANY EXISTING CONDITION SUCH AS DETERIORATION OR NON-COMPLYING CONSTRUCTION BE DISCOVERED WHICH IS NOT COVERED BY DSA-APPROVED DOCUMENTS WHEREIN THE FINISHED WORK WILL NOT COMPLY WITH TITLE 24 CALIFORNIA CODE OF REGULATIONS, A CONSTRUCTION CHANGE DOCUMENT, DETAILING AND SPECIFYING THE REQUIRED REPAIR WORK SHALL BE SUBMITTED TO AND APPROVED

<u>A PROJECT MANUAL IS AN INTEGRAL PART OF THE PROJECT DOCUMENTS</u>


THESE DRAWINGS AND SPECIFICATIONS FOR THE ITEMS LISTED IN THE SHEET INDEX HAVE BEEN PREPARED BY OTHER DESIGN PROFESSIONALS WHO ARE LICENSED TO PREPARE SUCH DRAWINGS IN THIS STATE. THESE DOCUMENTS HAVE BEEN EXAMINED BY ME FOR DESIGN INTENT AND APPEAR TO MEET THE APPROPRIATE REQUIREMENTS OF TITLE 24, CALIFORNIA CODE OF REGULATIONS AND THE PROJECT SPECIFICATIONS

THE ITEMS LISTED ABOVE HAVE BEEN COORDINATED WITH MY PLANS AND SPECIFICATIONS AND ARE ACCEPTABLE FOR INCORPORATION INTO THE CONSTRUCTION OF THIS PROJECT FOR WHICH I AM THE INDIVIDUAL DESIGNATED TO BE IN GENERAL RESPONSIBLE CHARGE.

STRUCTURAL DRAWINGS BY: D.C URFER & ASSOC., INC.

RENEWAL DATE: 02/28/2021



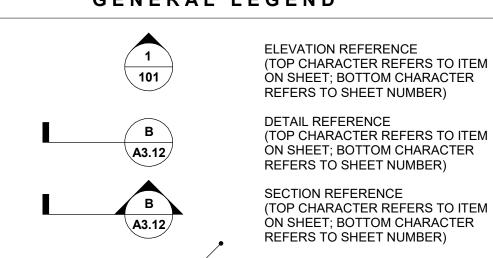

STRUCTURAL GRID IDENTIFIER

GRAPHIC SCALE

ELEVATION CALLOUT KEYNOTE CALLOUT **BREAK LINE** _____

ROOM NAME AND/OR NUMBER ENLARGED PLAN, SECTION OR ELEVATION REFERENCE BUBBLE (TOP CHARACTER REFERS TO ITEM ON SHEET; BOTTOM CHARACTER REFERS TO SHEET NUMBER)

Revision Schedule Description Drawn By: IAV

COVER SHEET, SHEET

INDEX, PROJECT DATA

NOTES, ABBREVIATIONS

SHEET TITLE:

SCALE: As indicated

astellano

Professional Seals

Checked By: CAS PROJECT # SHEET #

ISSUE DATE: 2020/10/26

SELF-ADHERE SHEET MEMBRANE

SQUARE FEET or SQUARE FOOT SIMIL AR SEE MECHANICAL DRAWINGS SPECIFICATIONS SQUARE FEET or SQUARE FOOT STORAGE STRUCTURAL or STRUCTURE SUSPENDED SYMMETRICAL **TOP & BOTTOM** TO BE DETERMINED **TEMPORARY TONGUE & GROOVE** THICK **TEMPERED**

TYPICAL UNDER COUNTER UNFINISHED

UNLESS OTHERWISE NOTED VERTICAL **VESTIBULE** VERIFY IN FIELD WATER CLOSET WOOD

WINDOW WATER RESISTANT WAINSCOT

WEIGHT WITH WITHOUT

CALIFORNIA BUILDING CODE

SHALL BE PERFORMED BY THE GENERAL CONTRACTOR. ALL ITEMS ARE EXISTING UNLESS IDENTIFIED AS NEW (N).

APPROVED BY THE ARCHITECT BEFORE ORDERING OR INSTALLING THE SUBSTITUTED ITEM(S).

OF THE ARCHITECT, AS APPROVED BY DSA AND AT THE EXPENSE OF THE GENERAL CONTRACTOR

PATCH & REPAIR (E) WALL TO PREVIOUS CONDITION WHERE HOLES ARE CUT FOR NEW BLOCKING OR BRACING.

CONTRACTOR TO PROVIDE TEMPORARY BARRIERS AROUND CONSTRUCTION AREAS TO PROTECT PEDESTRIANS ON SITE. ALL EXITS AND EXIT PATHS, FIRE LANES AND ACCESSIBLE PARKING STALLS SHALL REMAIN CLEAR AND UNOBSTRUCTED, FREE OF DEBRIS AND CONSTRUCTION MATERIAL.

FIRE SEVERITY ZONE MAP

CAL-FIRE SEVERITY ZONE:

VERY HIGH

NOT TO SCALE

REPRESENTATIVE OF DSA.


A PROJECT INSPECTOR, EMPLOYED BY THE DISTRICT AND APPROVED BY DSA, SHALL

DUTIES OF ARCHITECT PER SECTION 4-331 & 4-341 DUTIES OF CONTRACTOR PER SECTION 4-343

BY DSA BEFORE PROCEEDING WITH THE REPAIR WORK.

CRAIG A. SCOTT, ARCHITECT LICENSE #: C14508

PROJECT SITE NOTE: BASED ON LOCATION AS SHOWN ON FEMA MAP, THE PROJECT IS

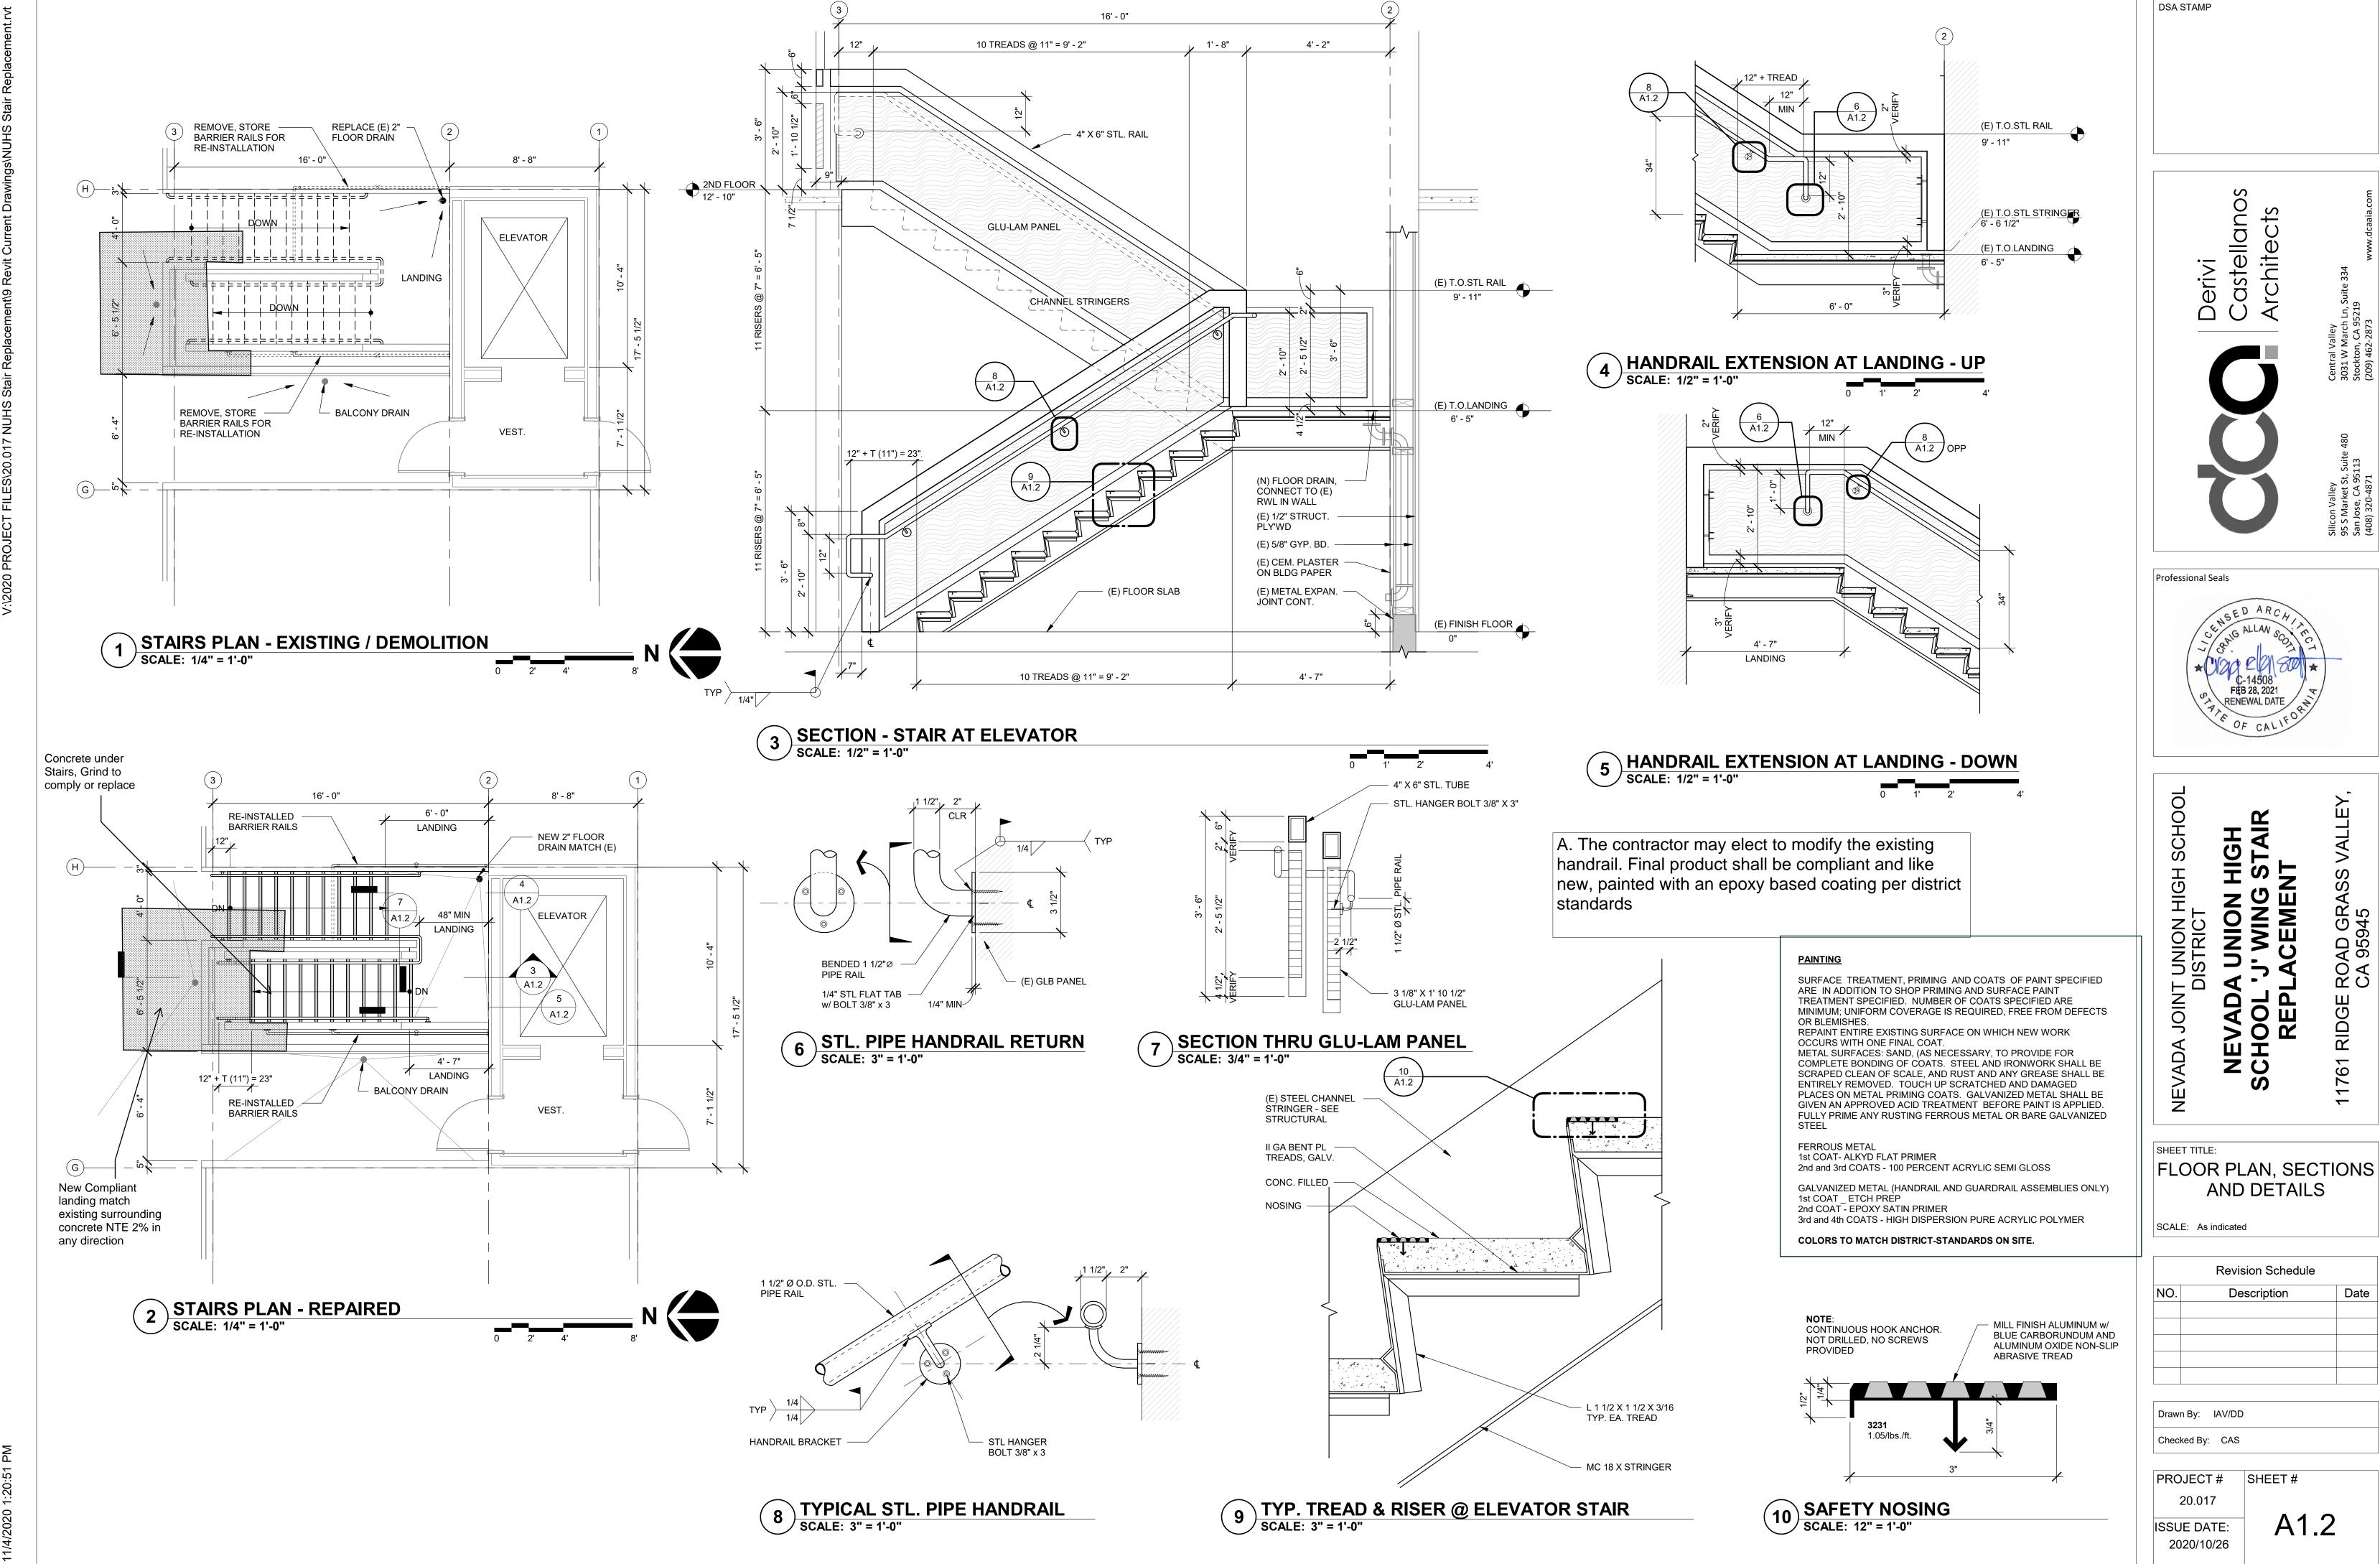

1/2020 1·20·51 PM

GENERAL NOTES

Site Condition: The Contractor shall examine and check all existing conditions, dimensions, levels and material and notify the Architect of discrepancies.

<u>Scope of Work:</u> The Scope of work includes the replacment of the exsting exterior concrete/metal pan steps and landing. The existing support framing will be cleaned, painted and re-used where practical.

Concrete: Concrete shall be proportioned to give a 28 day compressive strength of at least 4000 psi for stair treads and landing fill. The slump shall be the minimum consistent with the condition of placing but in general shall not exceed 4 inches. The water:cement ration shall not exceed 0.5. Use Type II cement and 3/8" max pea gravel. All concrete construction shall be in accordance with Chapter 19A of the California Building Code, 2019 Edition (Title 24).

Reinforcing Bars: Reinforcing steel shall be welded wire mesh conforming to ASTM Standard Specification AlO64, Grade 40, minimum. Lap mesh a minimum of one and one half meshes at splices. Use flat sheets, not rolls. All reinforcing steel shall be in accordance with Chapter 19A of the California Building Code, 2019 Edition (Title 24).

Bar coverage (face of bar to face of concrete) shall be as follows unless noted otherwise.

```
When poured against forms
exposed to weather or earth 1 1/2" min.
All others See details
```

Structural and Miscellaneous Steel: Plates and other structural and miscellaneous steel shall conform to ASTM A-36. Fabrication, erection, welding and painting shall be in accordance with the latest edition of the American Institute of Steel Construction Specifications. All steel exposed to weather shall be adjustived.

Sheet Metal Pans and Decking: Cold rolled steel plates for pans and decking shall conform to ASTM A653, Gr 50, galvinized.

Special Inspections: The following special inspections, as required by Section 1705A of the California Building Code, 2019 Edition, shall be provided during construction on the following types of work. The Contractor shall make arrangements for such tests, inspections and approvals with an independent testing laboratory or entity acceptable to the Owner. The Owner shall bear costs of the test and/or inspections.

```
A. Structural Welding, per Section 1705A.2. and Table 1705A.2.1;
B. Concrete, per Section 1705A.3 and Table 1705A.3;
```


B. Concrete, per Section 1705A.3 and Table 1705A.3; C. Reinforcing Steel, per Section 1705A.3 and Table 1705A.3.

General Design Criteria:

```
<u>Seismic:</u>
                                                                      <u> Wind:</u>
    Risk Category = ||1; | = 1.25
                                                                           Wind Exposure "C"
    Seismic Design Category = "D": Site Class "D"
                                                                           101 mph wind speed
    Ss = 0.563g;
                    S_1 = 0.235g
                     Fv = 1.5
    Fa = 1.0;
                                                                      <u>Live Loads</u>
    Sms = FaSs = 0.76q
    Sm_1 = FVS_1 = null^{-1}
                                                                           Stair Live Load = 100 psf
    Sds = \frac{2}{3} Sms = 0.507
    Sd_1 = \frac{2}{3}Sm_1 = null
Long: -121.054919
             39.24000
```


<u>Note</u>: All construction not specifically detailed shall be built to conform with similar construction shown and the requirements of the California Building Code, 2019 Edition (Title 24).

ABBREVIATIONS

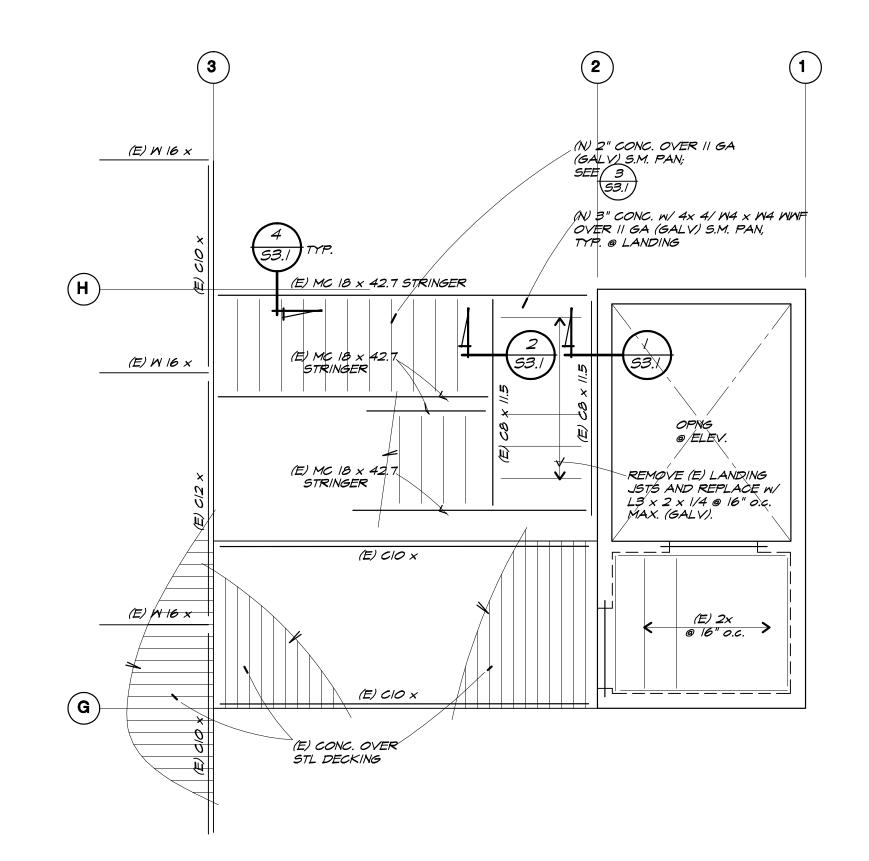

2ND FLOOR FRAMING PLAN

1/4" = 1'-0"

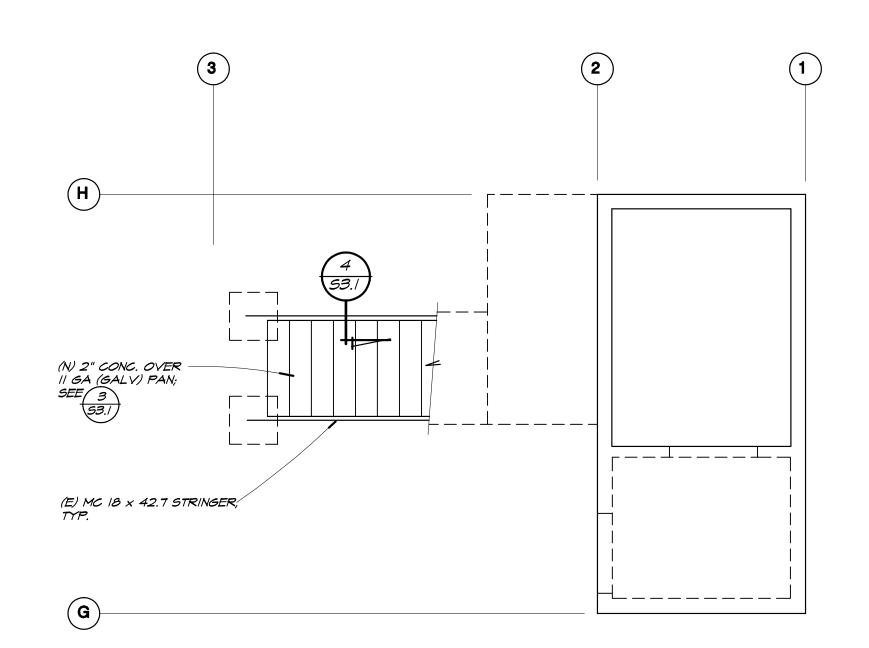




STAIR FOUNDATION PLAN

14"= 1'-0"

NOTES

I. SEE ARCHITECTURAL DRAWINGS FOR DIMENSIONS.



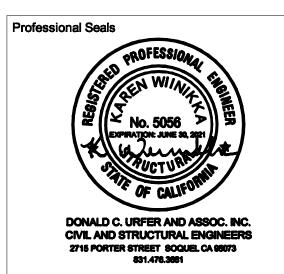

NEVADA UNION HIGH SCHOOL 'J' WING STAIR REPLACEMENT

SHEET TITLE:

STAIR FON PLAN,

2ND FLR FRMG PLAN

& GENERAL NOTES

SCALE: AS NOTED


Revision Schedule			
NO.	Description	Date	


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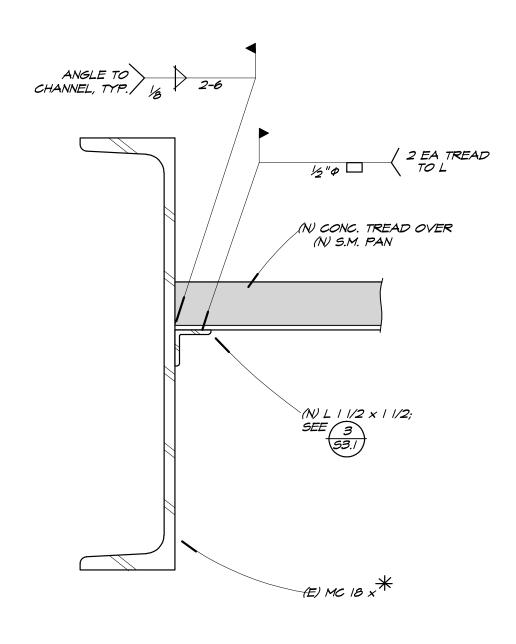
PROJECT#


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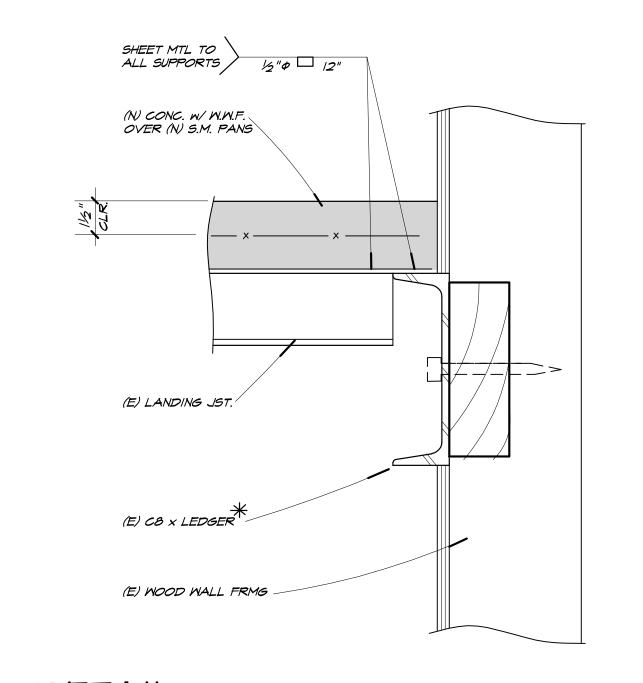
DATE:
11/3/20






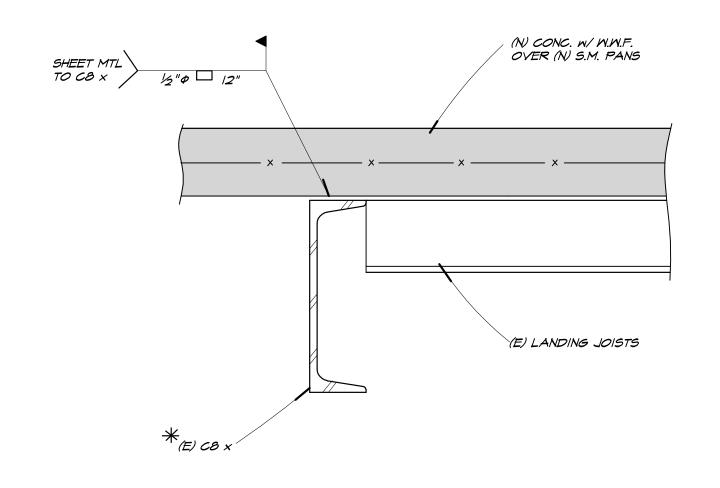

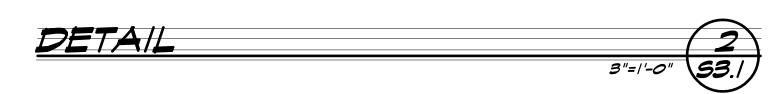

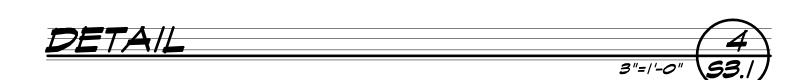

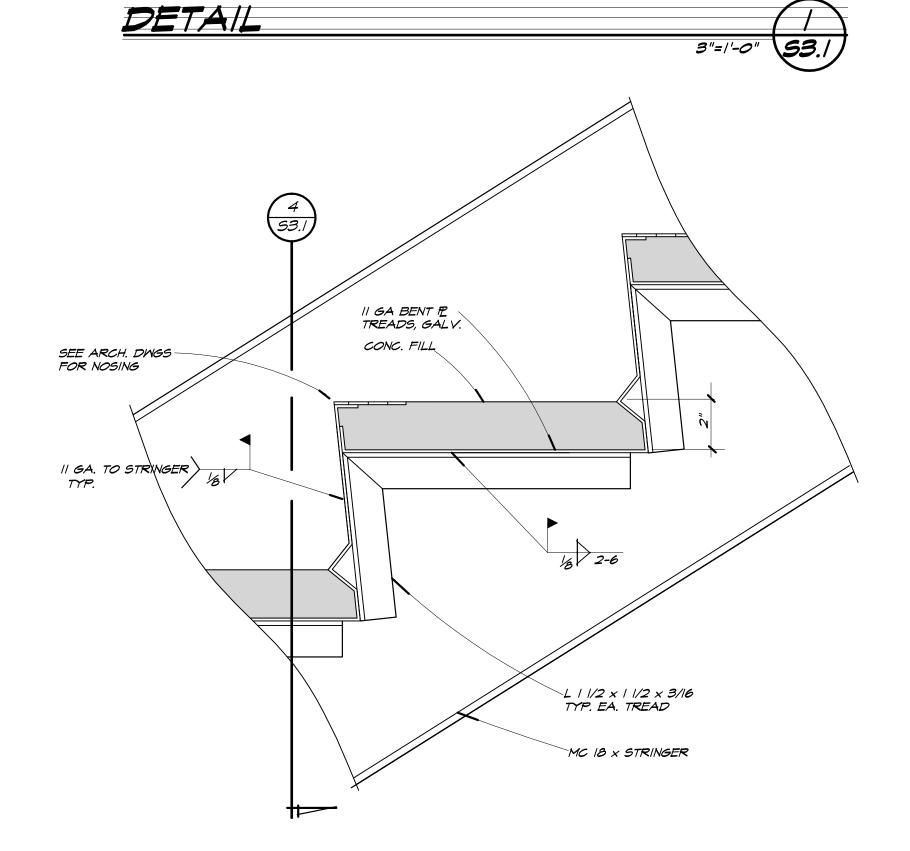


* REPAIR SEQUENCING

DETAIL

- I. REMOVE ALL (E) ANGLES, CLIPS, TABS, PLATES, ETC., FOR TREADS AND LANDING FRAMING; GRIND SURFACE TO REMAIN SMOOTH.
- 2. SAND BLAST (E) STEEL TO REMAIN UNTIL TO WHITE METAL FINISH.
- 3. FASTEN (N) STEEL TO (E).
- 4. PRIME STRUCTURAL STEEL
- 5. POUR CONCRETE FILL.
- 6. PAINT STRUCTURAL STEEL.



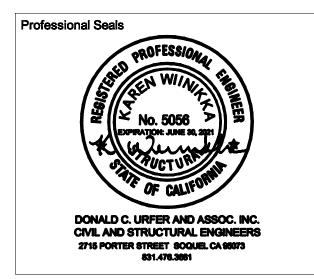

NEVADA UNION HIGH SCHOOL 'J' WING STAIR REPLACEMENT

SHEET TITLE:

DETAILS

SCALE: AS NOTED

Revision Schedule			
NO.	Description	Date	

Drawn By: SE.

Checked By:

PROJECT # SHEET #

DATE:

1 SEP 20 15:00 S.H.

S3.1